

EXTERIOR DOOR SCHEDULE CAMBOL OLIVITATA MIDTU DO LICIT DO MIDTU LINIT LICIT LINIT TUCK MATERIAL SYMBOL QUANTITY WIDTH RO HEIGHT RO WIDTH UNIT HEIGHT UNIT TYPE REMARK

WINDOW SCHEDULE

1 3'-0" 3'-0" 2'-10" 2'-10" CASEMENT

B 2 4'-7.75" 3'-10" 4'-5.75" 3'-8" CASEMENT © 1 4'-0" 2'-6.5" 3'-10" 2'-4.5" SLIDING ① 1 7'-6.5" 6'-0.5" 7'-4.5" 5'-10.5" CASEMENT **ⓑ** 1 2'-0" 3'-0" 1'-10" 2'-10" CASEMENT
 E
 1
 3'-2"
 6'-10.5"
 3'-0"
 6'-8.5"
 CASEMENT

© 1 4'-7.25" 3'-3.5" 4'-5.25" 3'-1.5" CASEMENT

SYMBOL	QUANTITY	WIDTH RO	HEIGHT RO	WIDTH UNIT	HEIGHT UNIT	THICK	MATERIAL	REMARK
1)	1	4'-5.5"	6'-10.5"	4'-3.5"	6'-8.5"	1 ³ / ₄ "	WOOD	FRONT DOOR
2	1	6'-3"	7'-10.5"	6'-1"	7'-8.5"	1 ½"	STEEL	FRENCH DOOR
INTERIOR DOOR SCHEDULE								
SYMBOL	QUANTITY	WIDTH RO	HEIGHT RO	WIDTH UNIT	HEIGHT UNIT			
3	2	5'-1.5"	6'-10"	4'-11.5"	6'-8"	1 ½"	WOOD	SLIDING DOOR
4	6	2'-8"	6'-10"	2'-6"	6'-8"	1 ½"	WOOD	
5	1	6'-2"	6'-10"	6'-0"	6'-8"	1 ½"	WOOD	
6	1	4'-1"	6'-10"	3'-11"	6'-8"	1 ½"	WOOD	

*20 MINUTE FIRE RATED (SELF - CLOSING AND SELF - LATCHING) DOOR PER R302.5.1

CLIMATE ZONE #2: FENESTRATION U-FACTOR .40 AND THE SOLAR HEAT GAIN COEFFICIENT IS .25 PER TABLE N1102.1.1 ZONE 2

		49'-0"	
		24'-2"	
		OOVEDED DODGU	
		G COVERED PORCH	
		10'-6"	
1	1		
		B 50 6 0'-4.5" 32'-2"	
	11-8"	BEDROOM 2 KITCHEN DINING POR BOOM POR B	
		Refrigerator Refrigerator	ē_
			240"
	N		SEC. A
28'-0"	120."		
8	72	3 10'-0" 3 SHOWER SHOWE	
	"4	MASTER LIVING ROOM	
	5	E & EDROOM BEDROOM	
		MASTER BATH (,)	
		8'-9" 1	
		COVERED PORCH	.0
+	*	COVERED PORCH	.08
			*
		8'-0" 12'-9" 10'-4" 11'-1"	

STUD WALL BRACING NOTES: BRACE WALLS PER IRC 2012				
METHOD	REFERENCE ON SHEET A1			
	R602.10.4			
	INTERIOR SHEATHING TABLE R602.3(1)			
CS-WSP	INTERIOR SHEATHING TABLE R602.3(2)			
	EXTERIOR SHEATHING TABLE R602.3(1)			
	R602.10.5			
CS-PS	R602.10.6.4			

R602.10.4.2 CONTINUOUS SHEATHING METHODS. CONTINUOUS SHEATHING METHODS REQUIRE STRUCTURAL PANEL SHEATHING TO BE USED ON ALL SHEATHABLE SURFACES ON ONE SIDE OF A BRACE WALL LINE INCLUDING AREAS ABOVE AND BELOW OPENINGS AND GABLE END WALLS AND SHALL MEET THE REQUIREMENTS OF SECTION R602.10.7.

NOTES:

HEADER SCHEDULE @ DOORS AND WINDOWS

2) 2"x6"

2) 2"x8"

2) 2''x|O''

2) 2''x|2''

USE #2 DOUG, FIR OR BETTER

MAX LOAD 800 LBS P.L.F.

2'-0''-4'-0''

4'-|''-6'-0''

6'-|''-8'-0''

8'-|"-9'-0"

CONTRACTOR TO VERIFY ALL DIMENSIONS & EXISTING SITE CONDITIONS PRIOR TO CONSTRUCTION.

CONTRACTOR SHALL VERIFY ALL INTERIOR FINISHES, FLOOR COVERINGS, AND TRIM SIZES & CONFIGURATIONS WITH OWNER PRIOR TO CONSTRUCTION.

IT IS THE SOLE RESPONSIBILITY OF THE CONTRACTOR TO VERIFY CLEARANCES OF THE ITEMS MENTIONED ABOVE PRIOR TO CONSTRUCTION.


REFER TO EXTERIOR ELEVATIONS FOR EXTERIOR WALL FINISHES.


REFER TO MANUFACTURERS SPECS FOR ROUGH OPENING DIMENSIONS, FOR DOORS AND WINDOWS.

CONTRACTOR SHALL MAKE ALL NECESSARY MODIFICATIONS DURING CONSTRUCTION PROCESS TO COMPLY WITH I.R.C. (INTERNATIONAL RESIDENTIAL CODE), 2018 AND APPLICABLE CODES AT SITE.



23'-8"

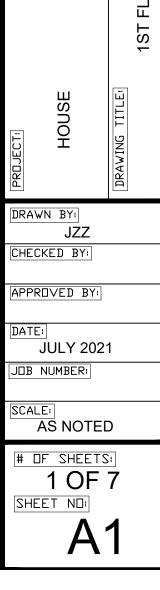


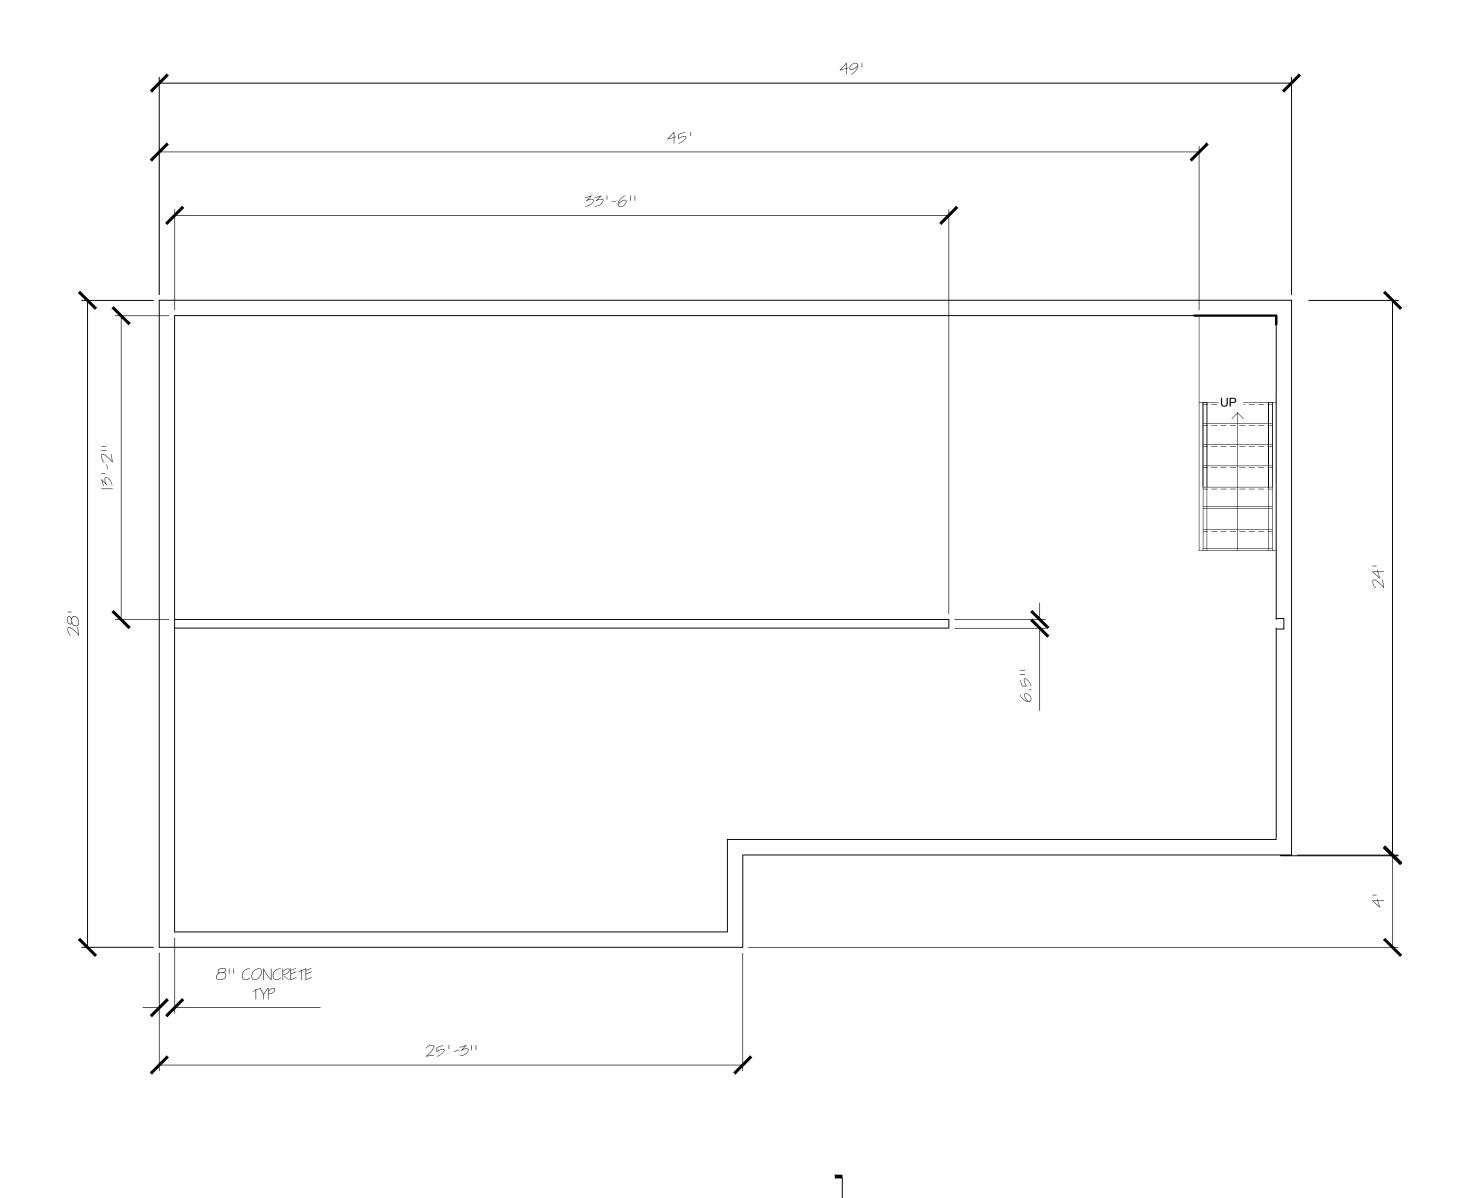

BASEMENT FLOOR PLAN N - 3/8" = 1'-0"


NOTES

- I. WALL SIZED BASED ON A MINIMUM SOIL PRESSURE OF 1500 PSF.
- 2. MINIMUM STRENAHT OF CONCRETE, 2500 PSI (IRC-R402.2) MINIMUM STRENAHT OF STEEL, 40 KSI.
- 3. ALL AREAS TO BE TERMITE TREATED PRIOR TO EACH CONCRETE POUR.
- 4. ALL FOOTINGS SHALL BE A MINIMUM OF 18'' INTO NATURAL / UNDISTURBED SOIL.
- 5. REBAR CLEARANCE CONCRETE CAST AGAINST EARTH
 SHALL BE 3'' AND SURFACE EXPOSED TO EARTH OR
 WEATHER 2''. WELDING OF REINFORCING STEEL IS
 NOT PERMITTED.

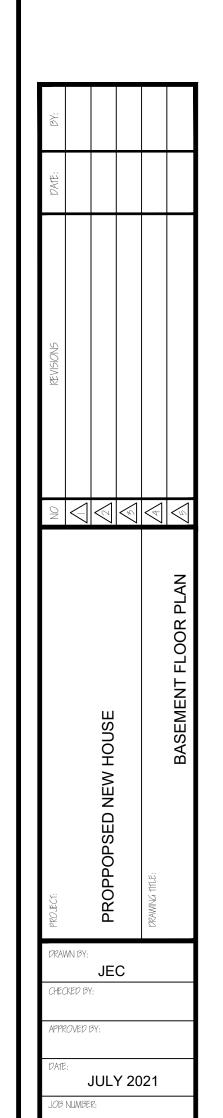

AS NOTED

2 OF 6

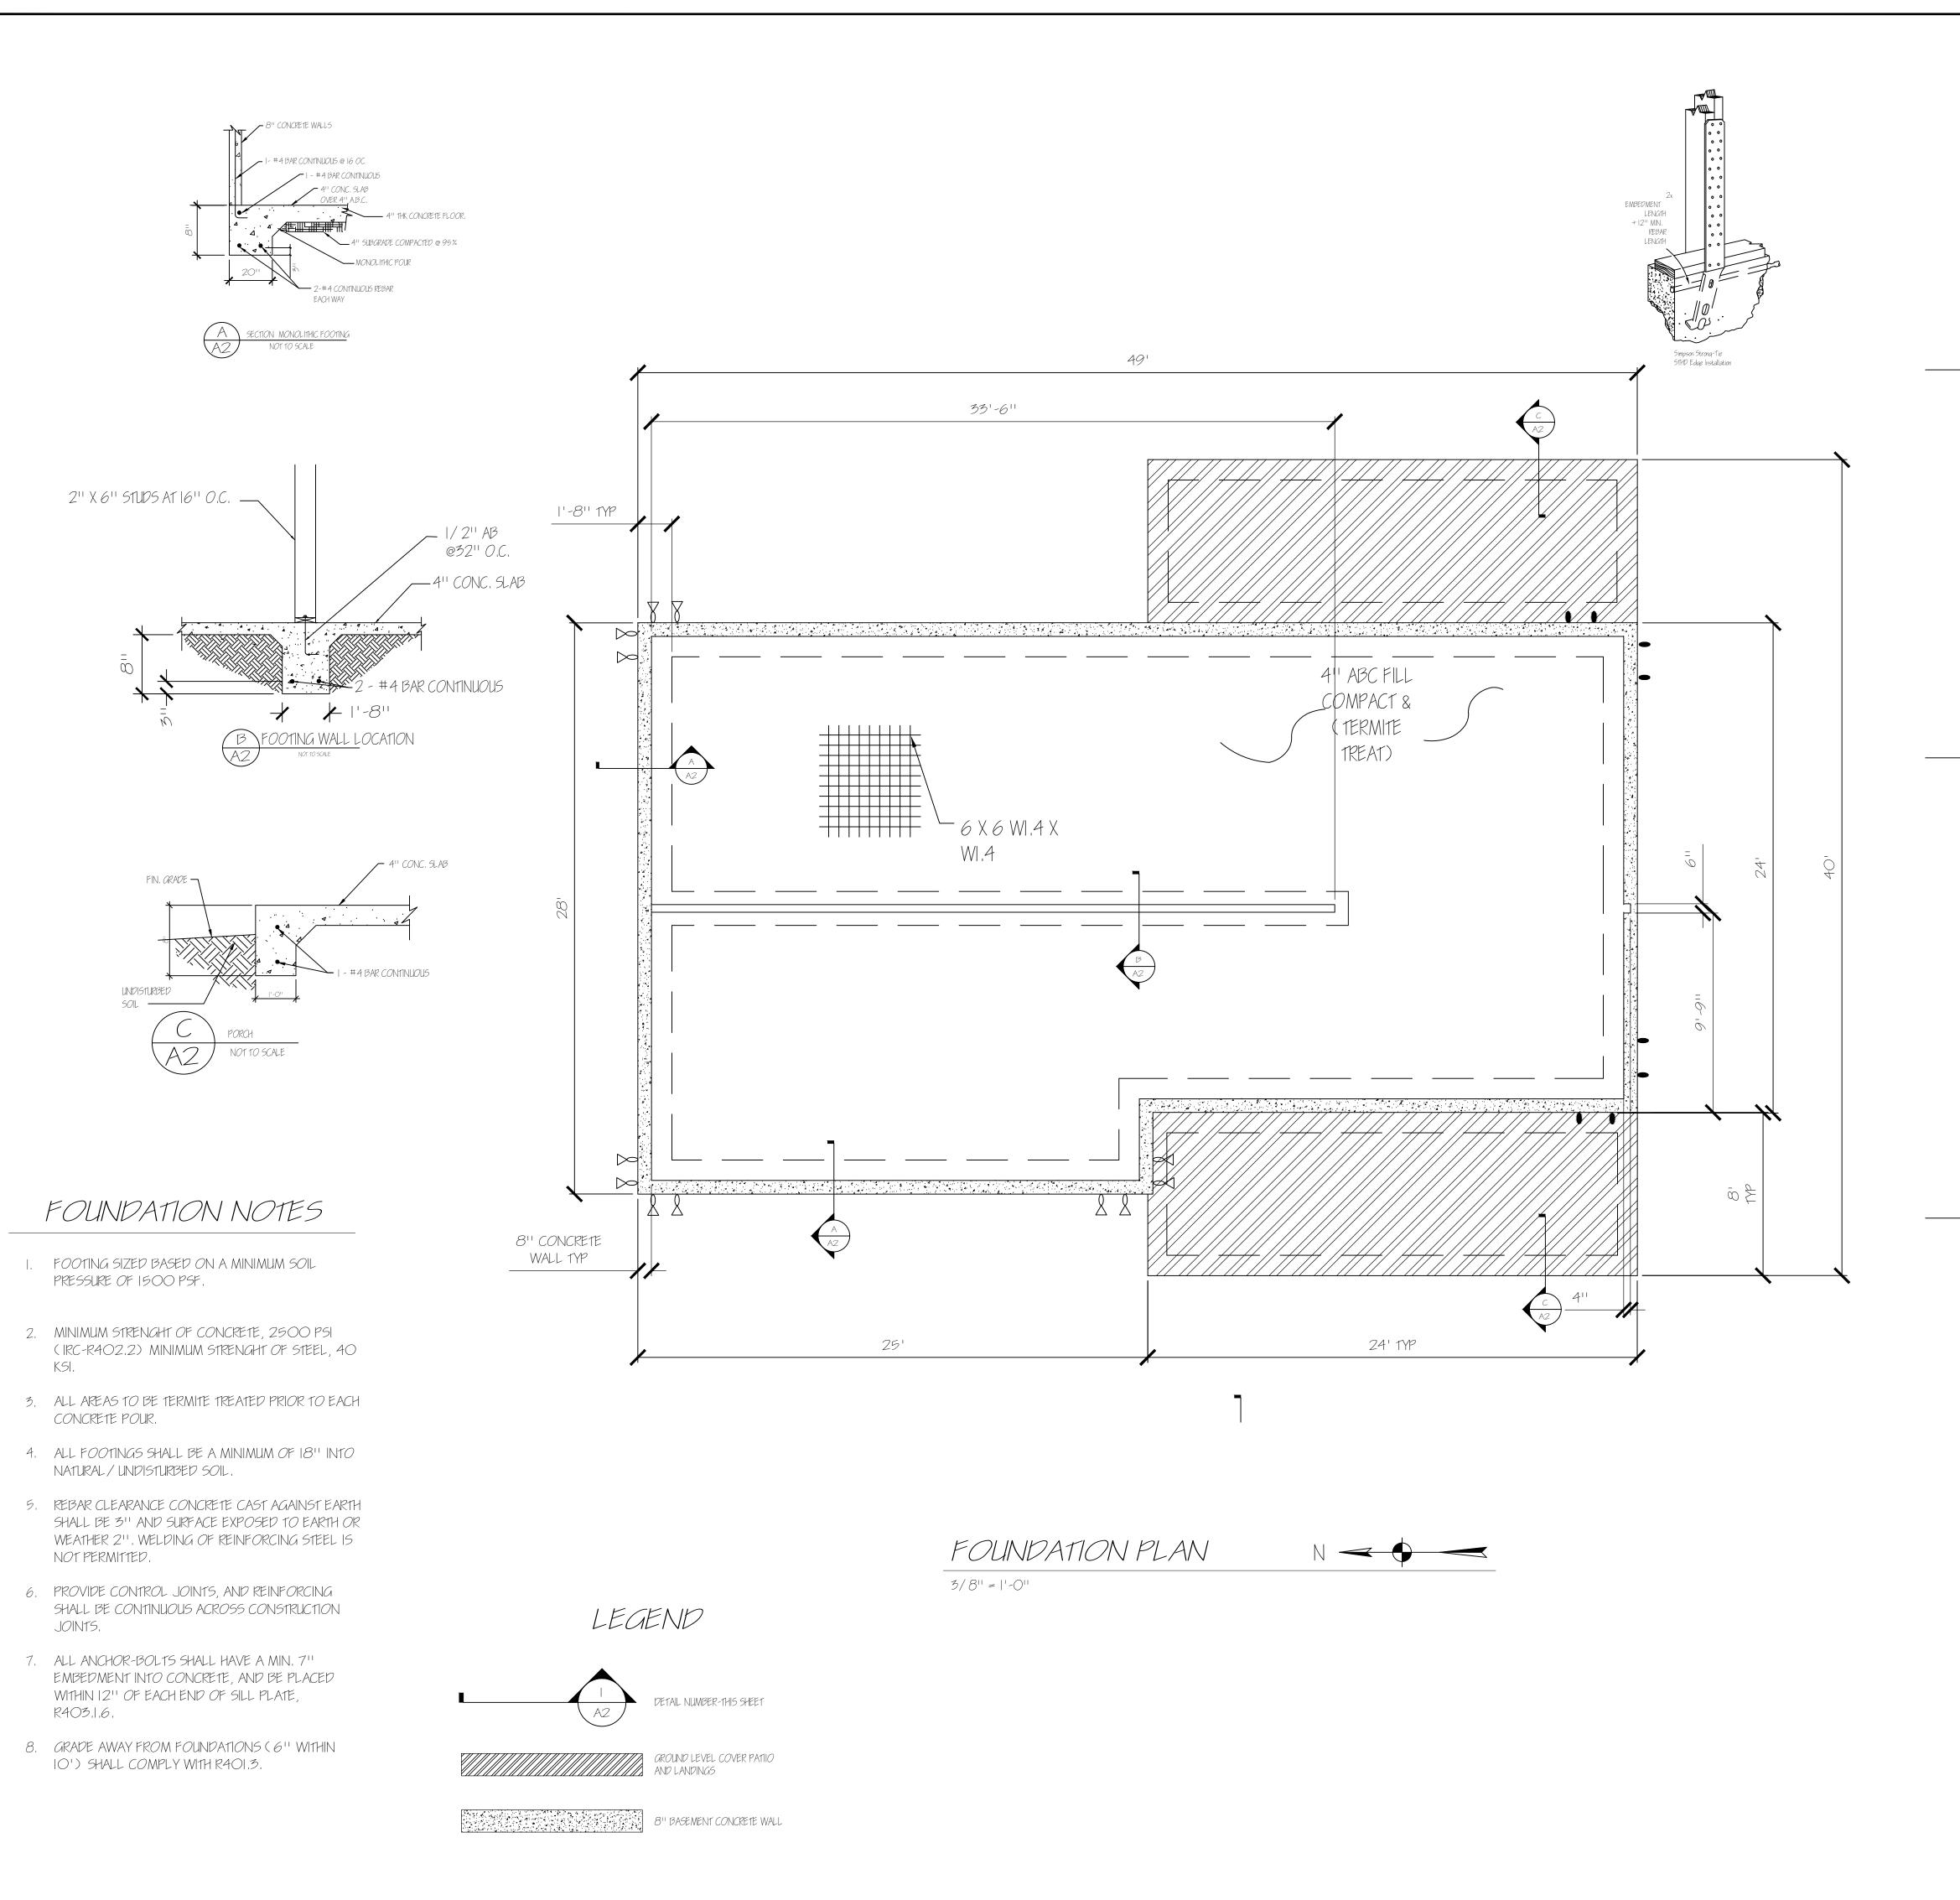

SHEAR WALL BRACED WALL SYMBOLS
SEE SHEAR WALL BRACING DETAIL BELOW

- BRACED WALL PANEL-48" STANDARD
 3/8" O.S.B. SHEATHING WITH 6d COMMON
 NAILS @6' O.C. AT ALL STUDS
- BRACED WALL PANEL-32" STANDARD
 3/8" O.S.B. SHEATHING WITH 8d COMMON
 NAILS @ 6' O.C. AT ALL STUDS
 2-ANCHOR BOLTS PROVIDED AT
 PANEL QUARTER POINTS
- △ SIMPSON PAHD42 OR EQUAL HOLDDOWNS


BRACED WALL PANEL NOTES

- I, BRACED WALL PANEL (BWP) SHALL BE PER IRC 2012 SECTIONS R602.10 THRU R602.11.2
- 2. BRACED WALL LINES SHALL CONSIST OF BRACED WALL PANELS WHICH MEET REQUREMENTS FOR LOCATION LOCATION, TYPE & AMOUNT OF BRACING SPECIFIED IN
- TABLE R602,10,5 & ARE IN LINE OR OFFSET NOT MORE THAN 48'' & SHALL NOT START MORE THAN 8'' FROM
- 3, EACH PANEL SHEATHED ON ONE FACE W/MI, 3/8" PLYWD W/ALL EDGES BLOCKED,
- 4. NAIL PLYWD 8d COMMON OR GALV. NAILS PER TABLE R602.3(1) IRC 2018
- 5. FOUNDATION SHALL BE CONTINUOUS ACROSS THE ENTIRE BRACED WALL LINE & REINFORCED W/ NOT LESS THAN 1-#4 BAR TOP AND BOTTOM.
- 6. MAX DISTANCE BETWEEN BRACED WALL PANELS=25' (FEET)

48" WIDE PANEL (BWP-48)

EACH END OF A BRACED WALL LINE.


I. SILL PLATE SHALL BE BOLTED TO FOUNDATION OR
SLAB IN ACCORDANCE WITH SEC. R403.1.6 IRC 2012
PLATE BOLTS SHALL BE MIN. I/2" DIA. W/7" MIN.
EMBEDMENT LOCATED WITH 7" OF EACH END OF
THE 48" BRACED WALL PANEL.

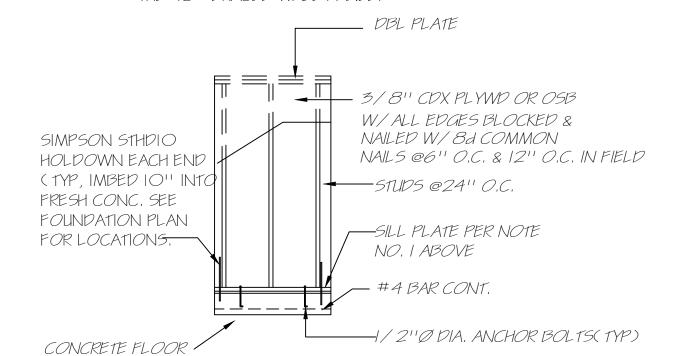

48" SHEARWALL ELEVATION NO SCALE

32" WIDE ALTERNATE PANEL (BWP-32)

- I. SILL PLATE SHALL BE BOLTED TO FOUNDATION OR SLAB IN ACCORDANCE WITH SEC. R403.1.6 IRC 2012 PLATE BOLTS SHALL BE MIN. 1/2" DIA. W/7" MIN. EMBEDMENT LOCATED WITH 10" OF EACH END OF THE 32" BRACED WALL PANEL.
- 2. EACH PANEL END STUD SHALL HAVE A TIE-DOWN
 DEVICE FASTENED TO FOUNDATION CAPABLE OF
 PROVIDING AN APPROVED UPLIFT CAPACITY OF
 NOT LESS THAN 1800 PD.(SIMPON PAHD42 OR EQUAL)

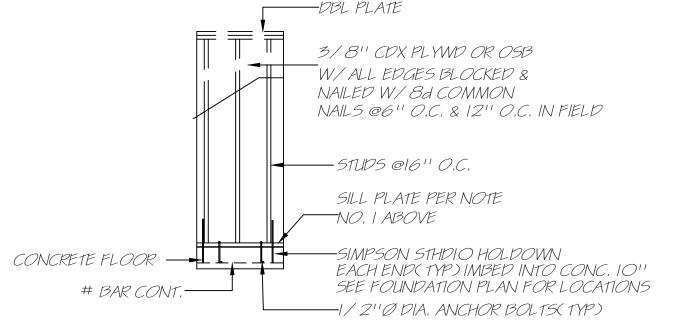

ALT. 32" SHEARWALL ELEVATION

NO SCALE

BRACED WALL PANEL DETAIL

NO SCALE


JEC JULY 2021 AS NOTED 3 OF 6

A3

ALE

FRAMING AND ROOFING NOTES

- I. FRAMING MEMBERS SHALL BE #2 OR BETTER DOUGLAS FIR.
- 2. STRUCTURAL MEMBERS SHALL BE ANCHORED PER IRC 2018.
- 3, GABLE ROOF WILL BE OF SHINGLE ROOFING AND IS TO BE SELECTED BY THE OWNER. OSB ROOF DECK TO HAVE AN OVERLAY OF 15 # ROOFING PAPER BELOW SHINGLES
- 4. JOINTS OF OSB OR PLYWOOD SHEATHING SHALL BE STAGGERED AND FASTENED WITH COMMON NAILS PER IRC 2018, FASTENING SCHEDULE TABLE R602.3
 FRAMING ANCHORS SHALL BE SIMPSON OR EQUAL.
- 5. ROOFING WILL CONTAIN WOOD TRUSS ALSO WILL CONTAIN BRACING FOR THE TRUSSES. SEE R502.11, R502.11.2
- 6. ALL ROOF RAFTERS ARE 2X6 @ 24" O.C..

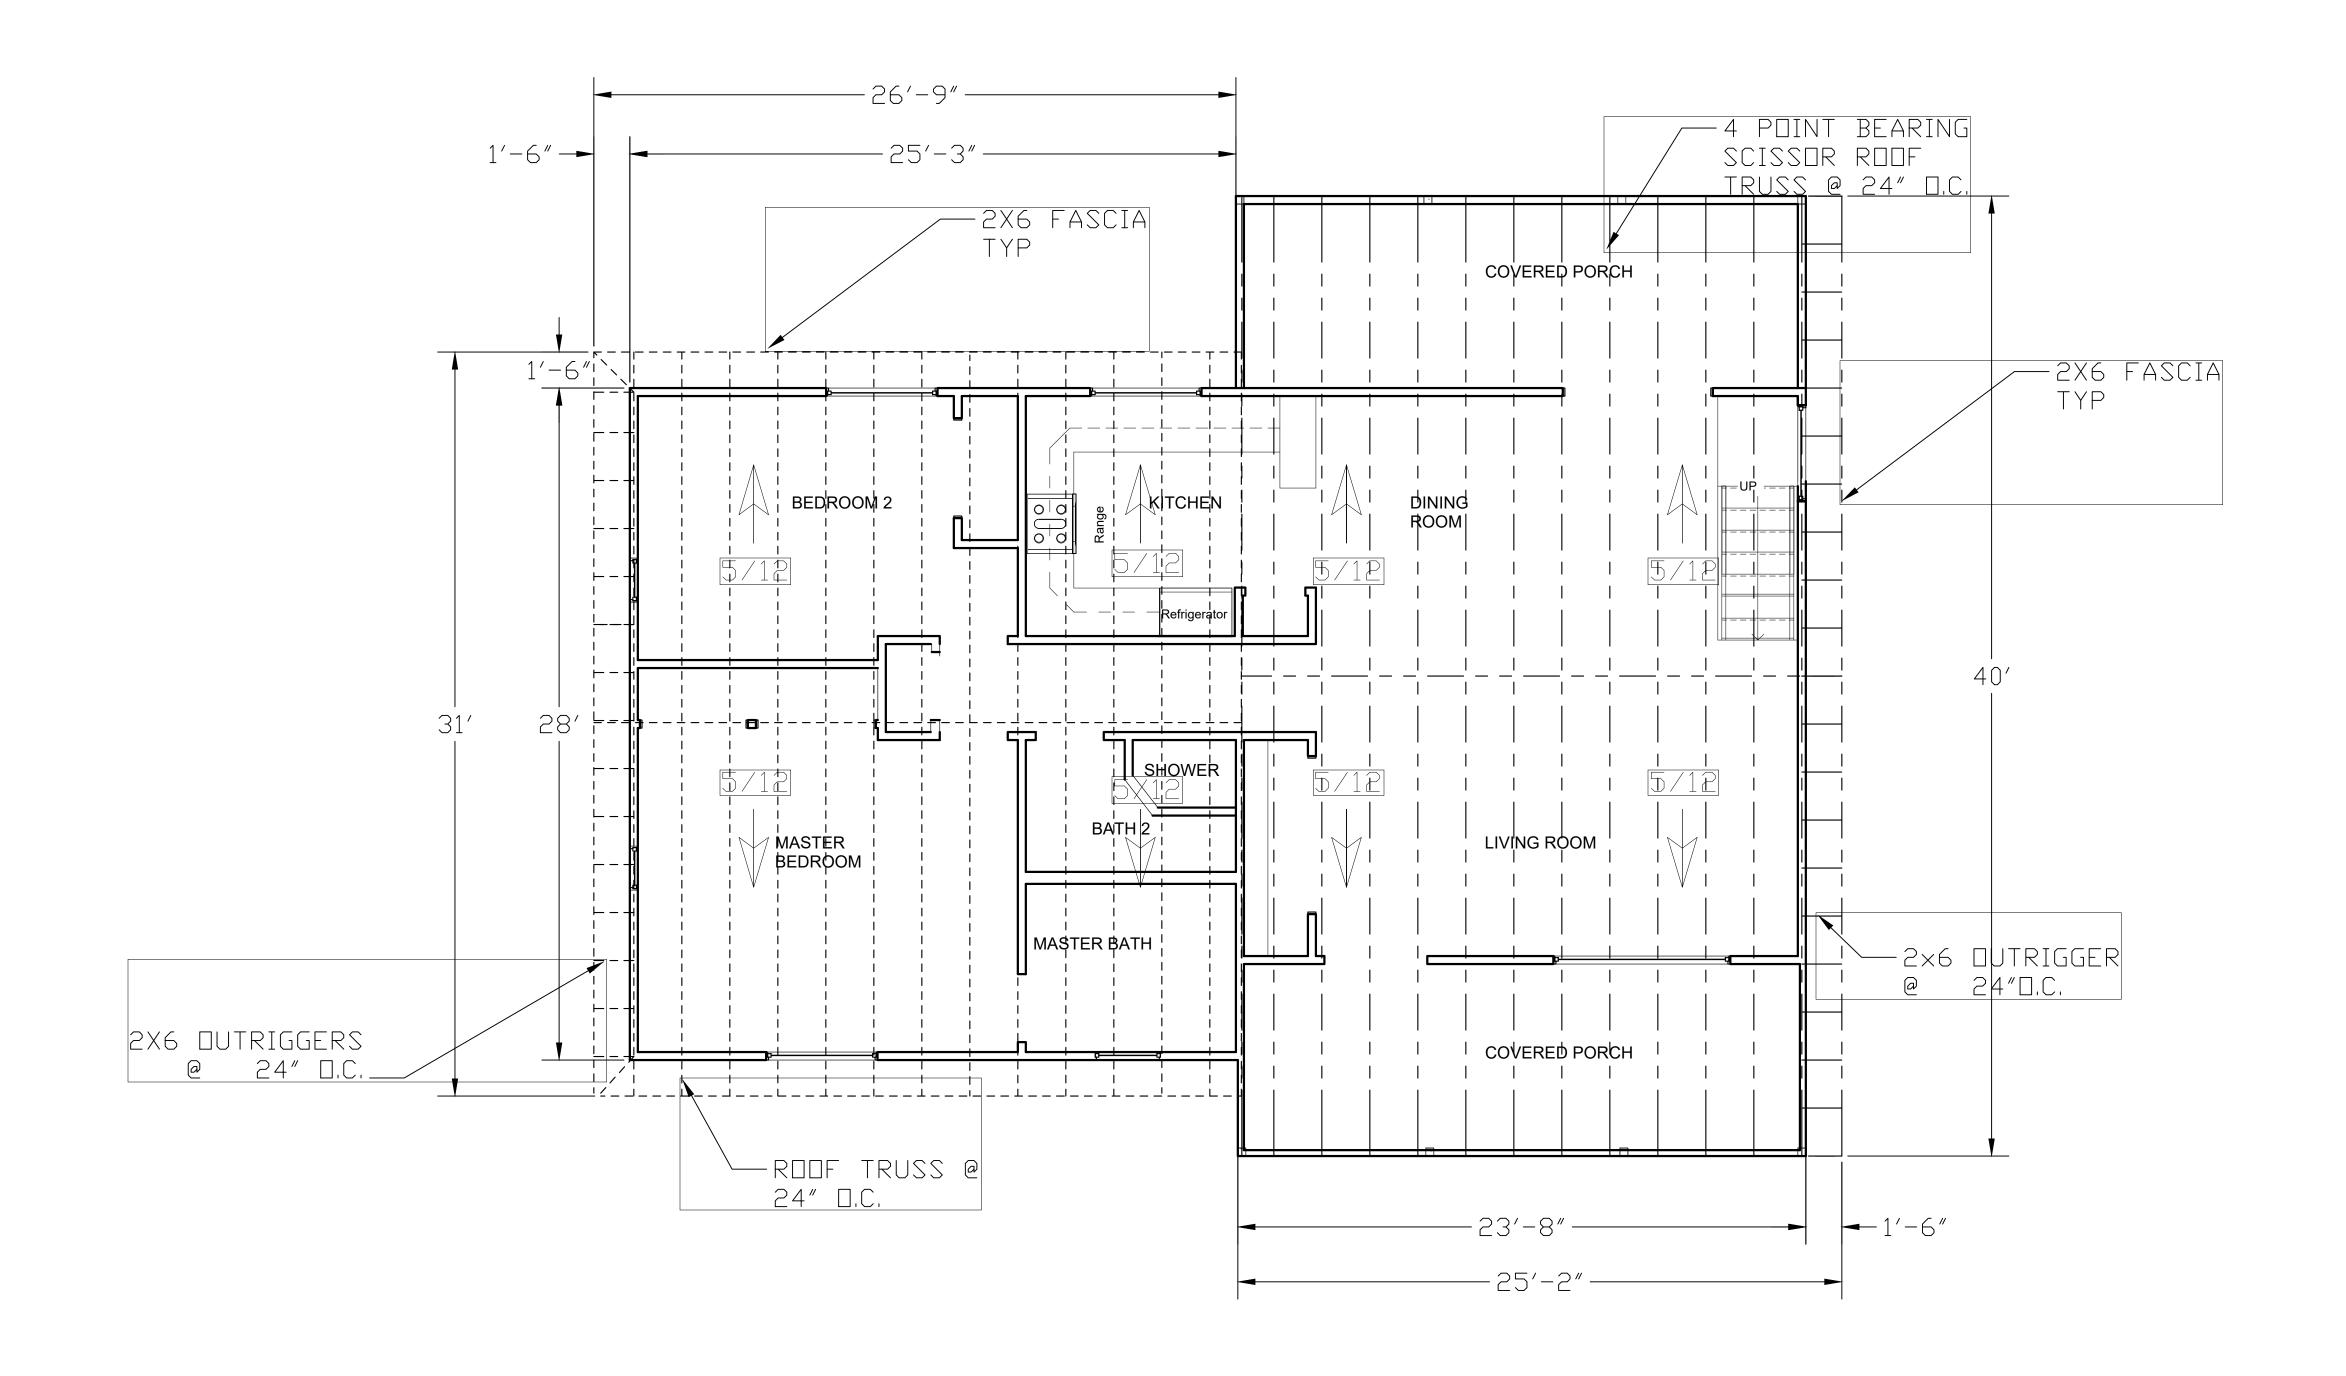





DRAWN BY: CHECKED BY: APPROVED BY: DATE: JULY 2021 JDB NUMBER: SCALE: AS NOTED # OF SHEETS: 4 OF 7

SHEET NO:

A4

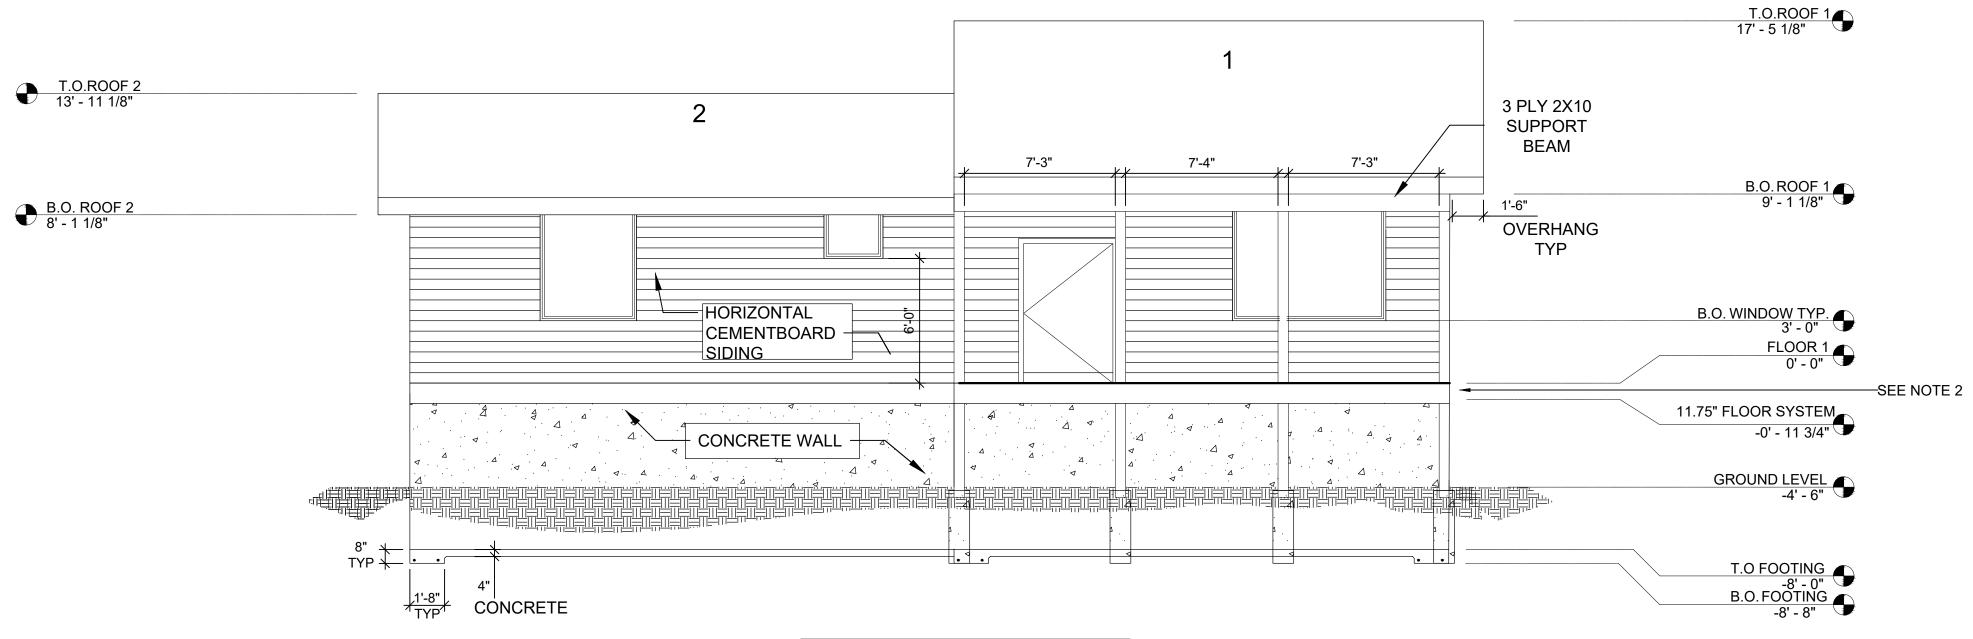

SOUTH ELEVATION

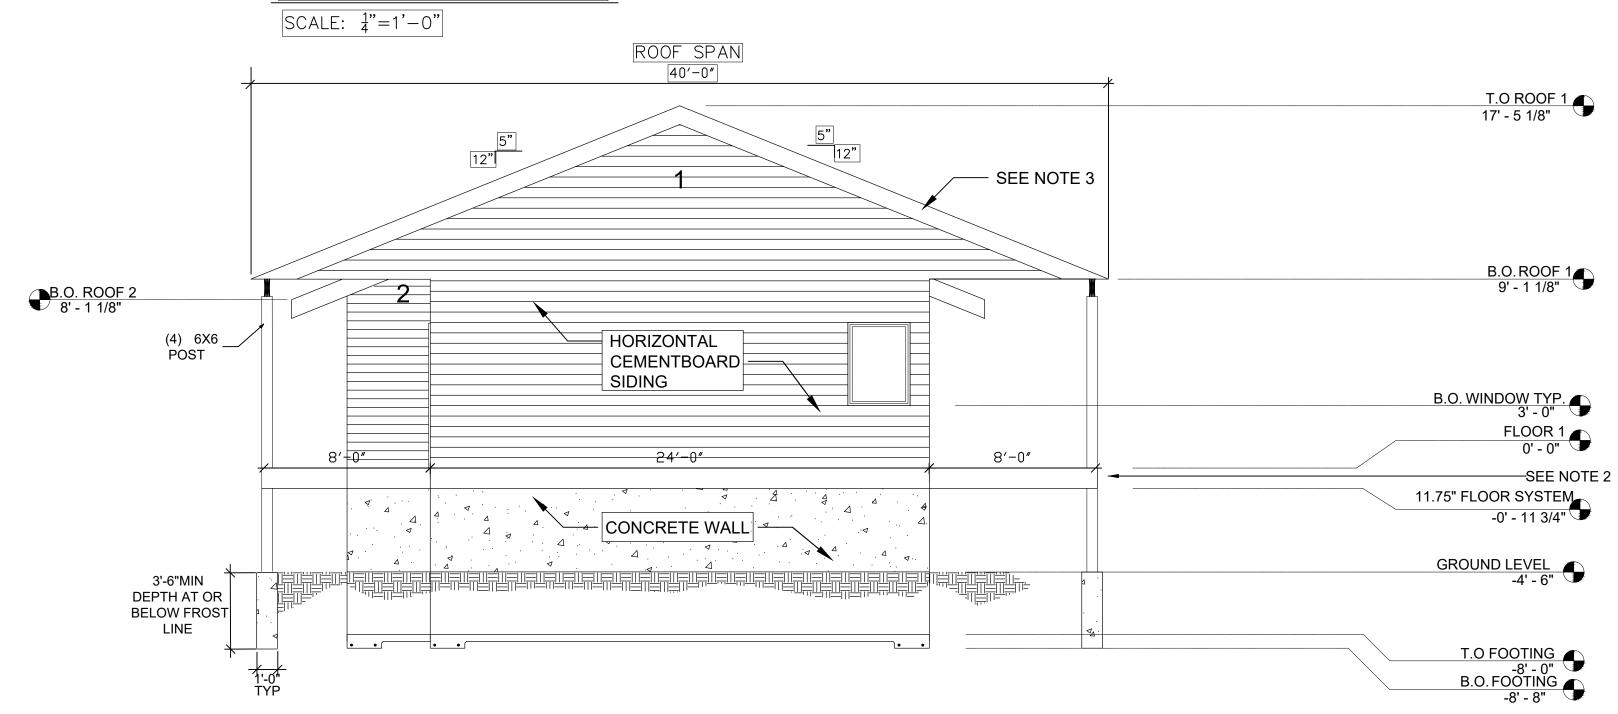

NOTES:


- 1. CONTRACTOR TO VERIFY ALL DIMENSIONS & EXISTING
- SITE CONDITIONS PRIOR TO CONSTRUCTION.

 2. FINISH FLOOR SHALL CONTAIN 9.5" I JOSIT HIGH FLOOR SYSTEM ON TOP OF SILL PLATE 1.5" ON TOP OF FOUNDATION WALL \(\frac{3}{4}\)" TONGUE & GROVE OSB FLOOR DECK. ATTACH WITH HWP/HWPH HANGERS.
- 3. ROOF TRUSS ARE 4 POINT BEARING SCISSOR ROOF TRUSS. TOP SLOPE IS $\frac{5}{12}$ AND BOTTOM SLOPE IS 3/12.
- 4. COVERINGS, AND TRIM SIZES & CONFIGURATIONS WITH CONTRACTOR SHALL VERIFY ALL INTERIOR FINISHES, FLOOR COVERINGS, AND TRIM SIZES & CONFIGURATIONS WITH OWNER PRIOR TO CONSTRUCTION.
- 5. IT IS THE SOLE RESPONSIBILITY OF THE CONTRACTOR TO VERIFY CLEARANCES OF THE ITEMS MENTIONED ABOVE PRIOR TO CONSTRUCTION.
- 6. REFER TO MANUFACTURERS SPECS FOR ROUGH OPENING DIMENSIONS, FOR DOORS AND WINDOWS.
- 7. CONTRACTOR SHALL MAKE ALL NECESSARY MODIFICATIONS DURING CONSTRUCTION PROCESS TO COMPLY WITH I.R.C. (INTERNATIONAL RESIDENTIAL CODE), 2012 AND APPLICABLE
- 8. REFER TO FLOOR PLAN FOR DOOR AND WINDOW SCHEDULE

EAST ELEVATION


SCALE: 1/4"=1'-0"

CHECKED BY: JEC APPROVED BY: JEC JULY_2021 JDB NUMBER: 0721RL 1/4"=1'-0" # OF SHEETS: 5 OF 7

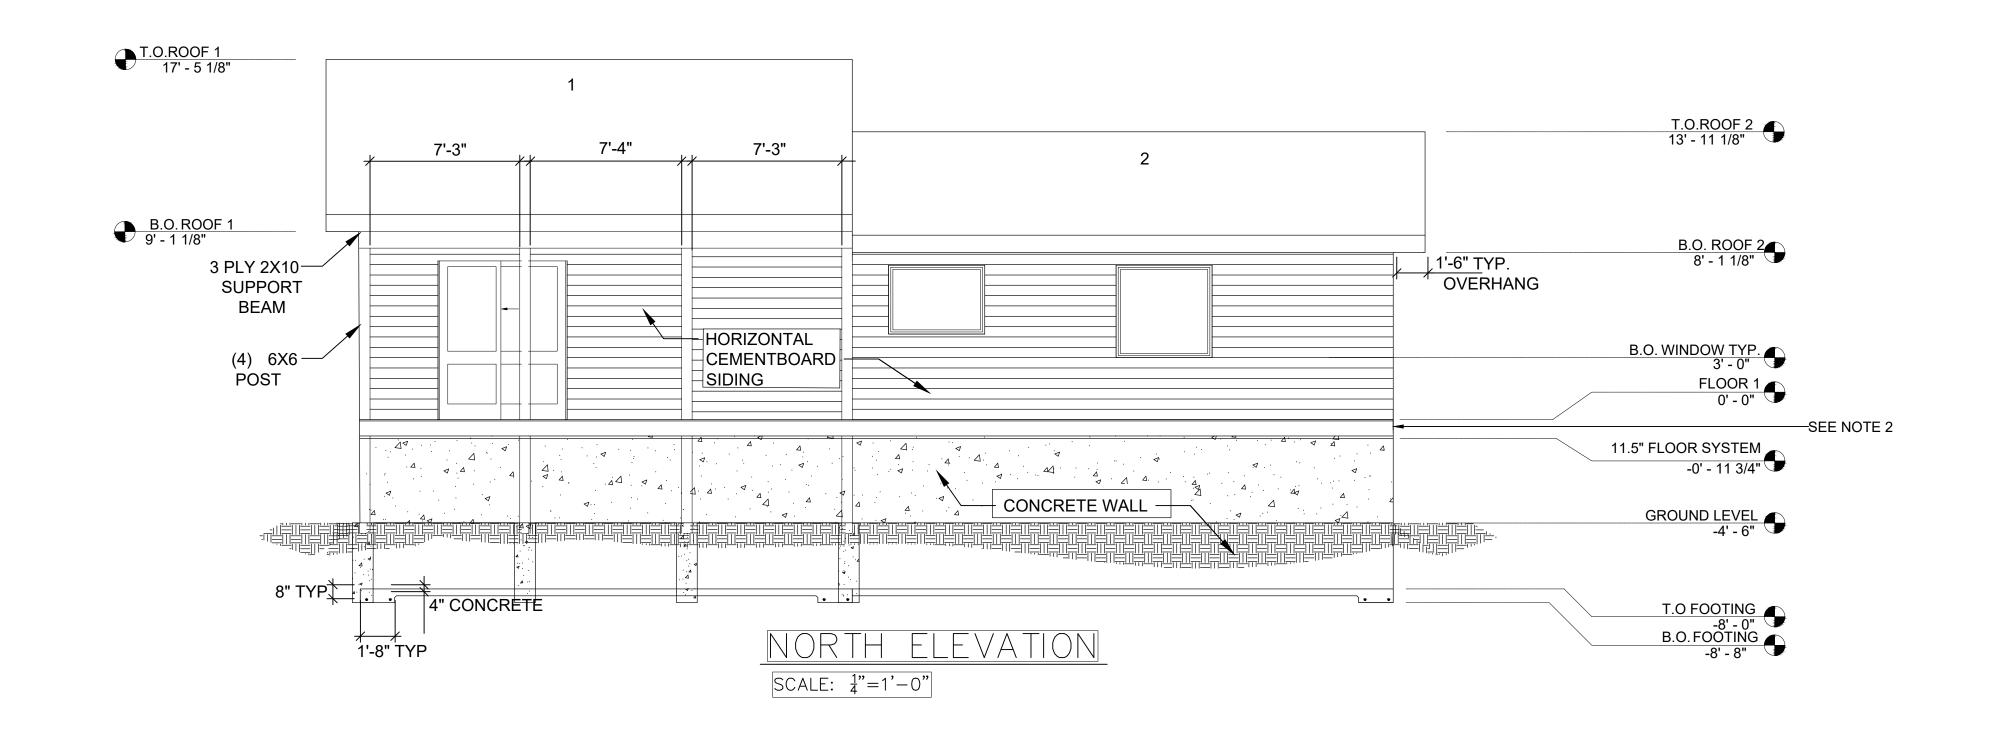

NOTES:


- 1. CONTRACTOR TO VERIFY ALL DIMENSIONS & EXISTING SITE CONDITIONS PRIOR TO CONSTRUCTION.
- 2. FINISH FLOOR SHALL CONTAIN 9.5" I JOSIT HIGH FLOOR SYSTEM ON TOP OF SILL PLATE 1.5" ON TOP OF FOUNDATION WALL \(\frac{3}{4}\)" TONGUE & GROVE OSB FLOOR DECK. ATTACH WITH HWP/HWPH HANGERS.
- 3. ROOF TRUSS ARE 4 POINT BEARING SCISSOR ROOF TRUSS. TOP SLOPE IS $\frac{5}{12}$ AND BOTTOM SLOPE IS 3/12.
- 4. COVERINGS, AND TRIM SIZES & CONFIGURATIONS WITH CONTRACTOR SHALL VERIFY ALL INTERIOR FINISHES, FLOOR COVERINGS, AND TRIM SIZES & CONFIGURATIONS WITH OWNER PRIOR TO CONSTRUCTION.
- 5. IT IS THE SOLE RESPONSIBILITY OF THE CONTRACTOR TO VERIFY CLEARANCES OF THE ITEMS MENTIONED ABOVE PRIOR TO CONSTRUCTION.
- 6. REFER TO MANUFACTURERS SPECS FOR ROUGH OPENING DIMENSIONS, FOR DOORS AND WINDOWS.
- 7. CONTRACTOR SHALL MAKE ALL NECESSARY
 MODIFICATIONS DURING CONSTRUCTION PROCESS
 TO COMPLY WITH I.R.C. (INTERNATIONAL
 RESIDENTIAL CODE), 2012 AND APPLICABLE
- 8. REFER TO FLOOR PLAN FOR DOOR AND WINDOW SCHEDULE

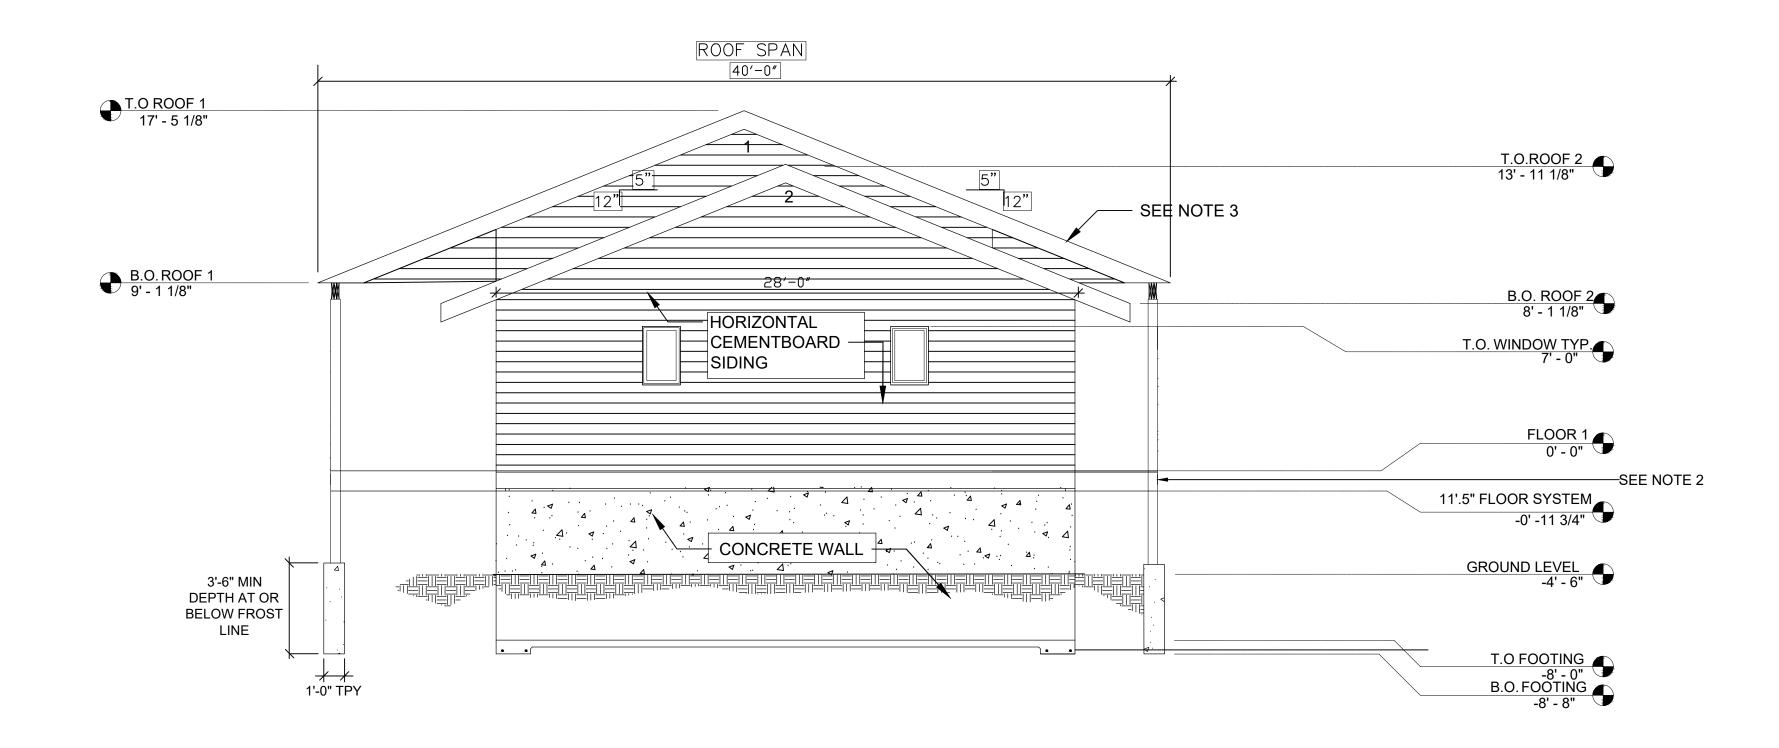



WEST ELEVATION

SCALE: 1/4"=1'-0"

	DATE: BY:					
	REVISIONS					
		4	\$	(E)		\$
	Z	ŢĮ.	To the second		4	The state of the s
	PROJECT:	HSTICH			DRAWING TITLE:	ELEVATIOS
		ECKE	JJ. D B			
		PROV	JJ. ED	Z BY:		
	DA ⁻		JJ: LY	Z 202	1	
	JOI	C NU	 мвея)516	2:		
	SCA	1/	4"=1			
	#	OF IEET		ETS	Ol	F
	ادا	<u> </u>		<u>\</u>	6	

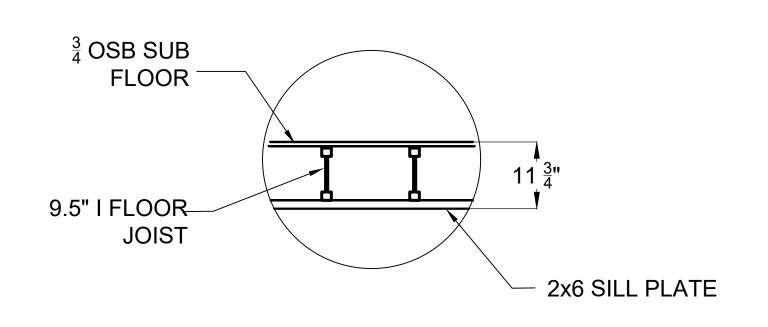

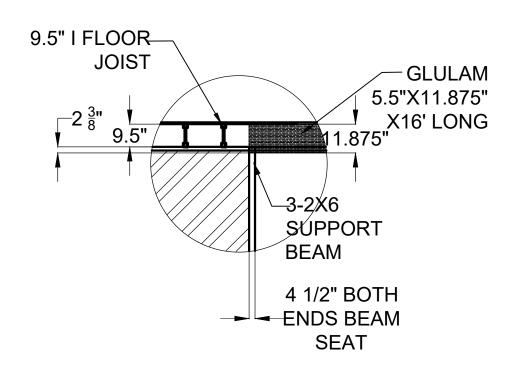


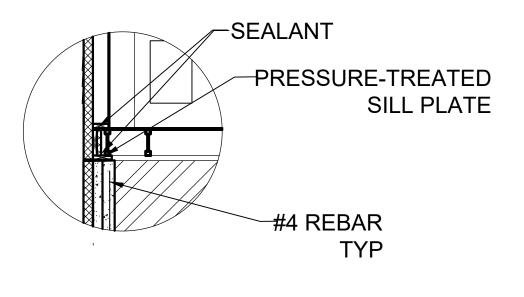


DETAIL A
NO SCALE

DETAIL B
NO SCALE

DETAIL C NO SCALE

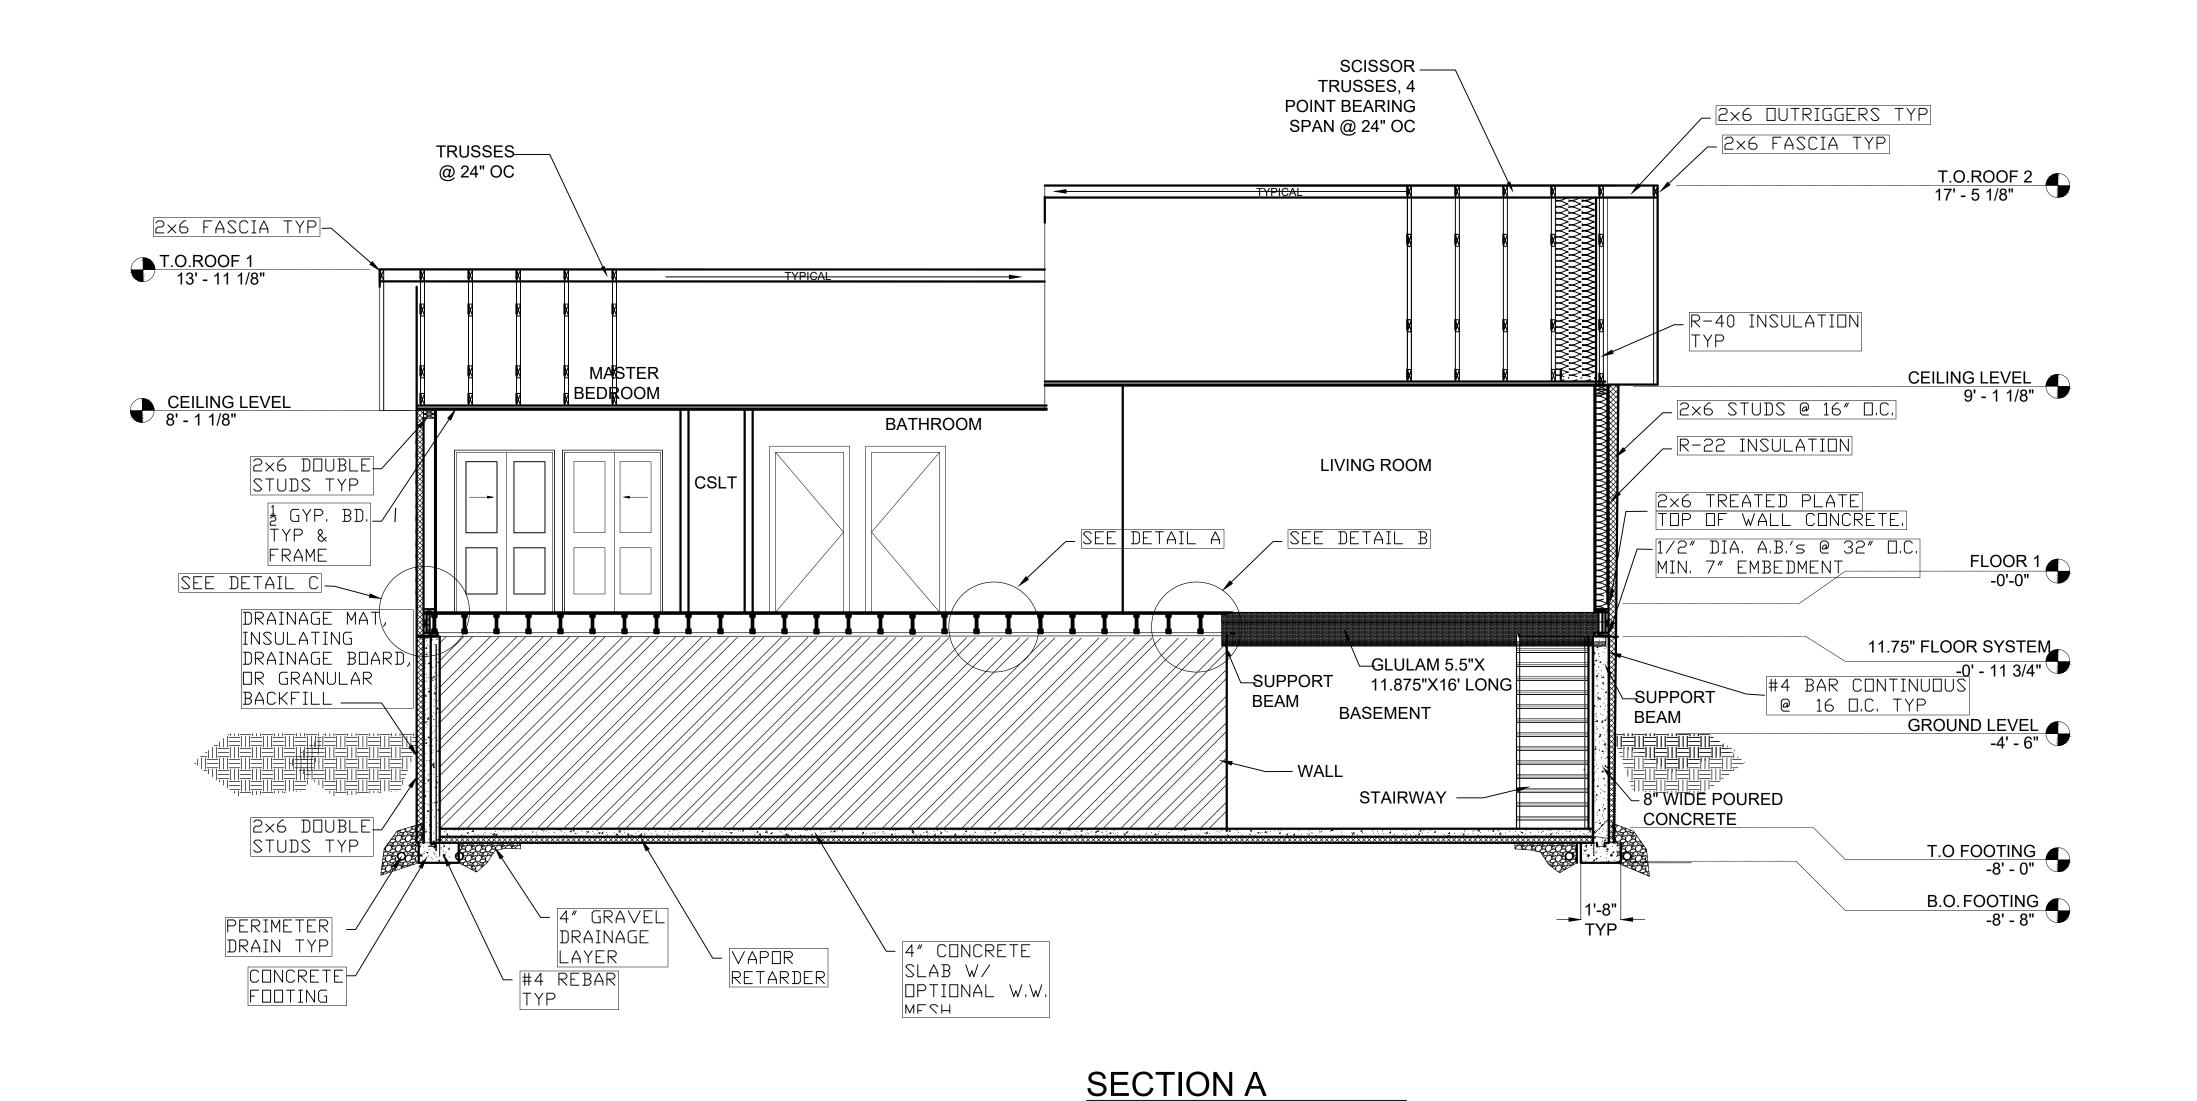

1/4" = 1'-0"

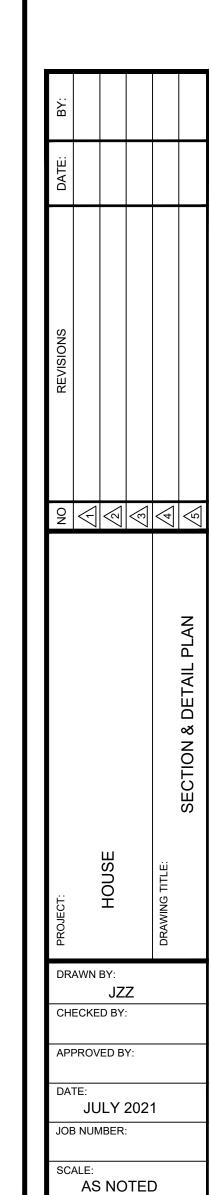

OF SHEETS:

SHEET NO:

7 OF 7

A7